PLYMOUTH CARRIAGE BARN KIT FOR:

JEFF & COLLEEN GANGL

IT KENNADAY RD MENDHAM, NJ 07945



18' x 26' POST & BEAM CARRIAGE BARN KIT

REVISION DATE: 03/13/2023 REVISION #: 3



DRAWING LIST

TITLE SHEET & DESIGN DATA ELEVATIONS SHEET 2 FOUNDATION PLAN SHEET 3 POST PLAN SHEET 4 FRAMING PLANS FRAMING SECTIONS SHEET 6 UTILITY CHASE DETAILS SHEET T NOTES & DETAILS

THE BARN YARD


MANUFACTURING & DESIGN FACILITY 9 YILLAGE ST. ELLINGTON, CT 06029 860,454,9103

SHOWCASE LOCATIONS

120 WEST RD.

ELLINGTON, CT 06029 BETHEL, CT 06801 203,740,7433 860.896.0636

www.greatcountrygarages.com CT LICENSE * 558916 MA LICENSE * 127550

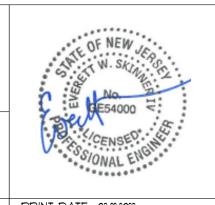

NOTE:

ELEVATIONS & RENDERINGS ARE ARTISTS CONCEPTIONS. COLOR AND OPTION STYLES MAY DIFFER FROM ACTUAL CONSTRUCTION.

PROJECT NO. 1617

PRINT DATE: 03.22.2023

DUILDING MATERIAL COURDING				
BUILDING MATERIAL SCHEDULE				
ITEM	DESCRIPTION	FINISH / COLOR		
ROOF ASSEMBLY				
ROOF DECKING	IX8 T&G PINE V-GROOVE DECKING	N/A		
ROOF INSULATION	10.125" EPS SIPS	N/A		
WEATHER BARRIER	*15 FELT PAPER	N/A		
VENT LAYER	ix3 YERT, FURRING @ 24" O.C.	N/A		
ROOFING	METAL ROOFING (BY OTHERS)	TBD		
FASCIAS	IX PINE W/ IX3 PINE SHADOW BOARD	NONE		
OVERHANGS	IX SHIPLAP PINE	NONE		
RAKES	IX PINE W/ IX3 PINE SHADOW BOARD	NONE		
WALL ASSEMBLY				
INTERIOR SIDING	IX8 VERTICAL SHIPLAP PINE SIDING	NONE		
WALL INSULATION	4.5" NEO SIPS	NONE		
UTILITY CHASE	2x4 FURRING @ 24" O.C. VERT. (BY OTHERS)	N/A		
WEATHER BARRIER	FELT PAPER	N/A		
VENT LAYER	1x3 FURRING @ 24" O.C. VERT.	NONE		
EXTERIOR SIDING	IX8 VERTICAL SHIPLAP PINE SIDING	NONE		
EXTERIOR TRIM	IX4 PINE	NONE		

NOTE: ALL IX PINE FOR FASCIAS, RAKES, SOFFITS & TRIM SHALL BE CUT FROM IX8 PINE SHIPLAP SIDING

TBY CONSTRUCTION SCOPE OF SERVICES

SUPPLIED BY TBY AND INSTALLED BY OTHERS:

- STRUCTURAL TIMBER FRAME COMPONENTS
- WINDOWS & DOORS
- IX8 T4G PINE V-GROOVE LOFT FLOORING IX8 T4G PINE V-GROOVE ROOF DECKING
- 1X8 SHIPLAP PINE SIDING & TRIM HARDWARE KITS FOR SPLIT SLIDER DOORS
- WALL & ROOF SIPS


EXCLUSIONS INCLUDE BUT ARE NOT LIMITED TO:

- FOUNDATION
- ROOFING MATERIAL - UTILITY CHASE


PER CONTRACT NO. 7617 AND ANY APPROVED CHANGE ORDERS

ANDERSEN 400 SERIES WINDOW SCHEDULE					
LETTER	QTY	MODEL	COLOR	∰ ₹	RGH, OPG (WXH)
\triangle	2	2446 DOUBLE HUNG	BLACK	YES	2'-6 1/8" x 4'-8 7/8"
В	4	2446 DOUBLE HUNG	BLACK	NO	2'-6 1/8" x 4'-8 7/8"
(C)	5	A281 AWNING	BLACK	0	2'-8" × 2'-0 5/8"
Ð	1	2446-3	BLACK	NO	7'-5 5/8" x 4'-8 7/8"
ANDERSEN A SERIES WINDOW SCHEDULE					
E	2	FW6LD-1-13611	BLACK	YES	1'-3" × 6'-11"
F	1	FWTDS CUSTOM	BLACK	NO	113" × 12"


DOOR SCHEDULE						
LETTER	QΤΥ	MANUF,	MODEL	COLOR	RGH, OPG (WXH)	
A	1	ANDERSEN	A SERIES 60611 HINGED DOUBLE PATIO DOOR W/ ALBANY HANDLE, COLONIAL GRILLE \$ 3.5" FLAT LOW- E4 GLASS TRIM	BLACK	6'-0" × 6'-11"	
Æ	1	CUSTOM	3070 SPANISH CEDAR W/ 6-LITE HALF GLASS & CROSSBUCKS	N/A	3'-2 3/4" x T'-3 1/2"	
A	1	TBY	DOUBLE SPLIT SLIDER	N/A	9'-5" × 8'-10"	

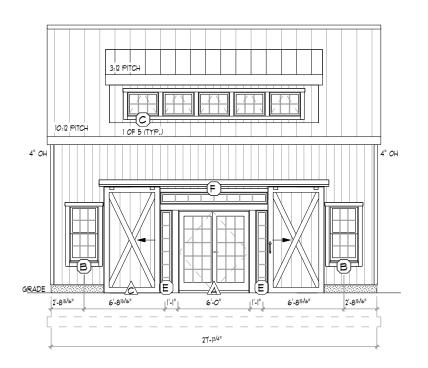




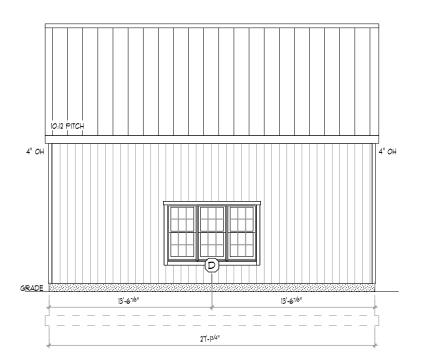



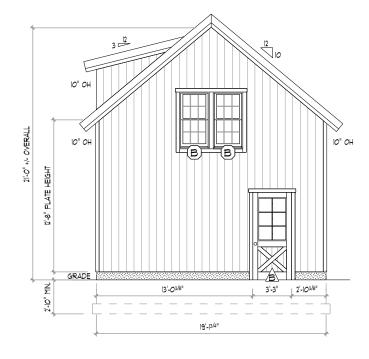

3 RIGHT ELEVATION TF-1 SCALE: 1/8" = 1'-0"

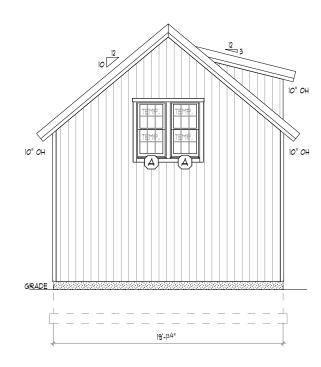






ELEVATIONS


03-22-23 AS NOTED DRWN BY:

TF-1 OF 7 EWS PROJECT ID: 7617

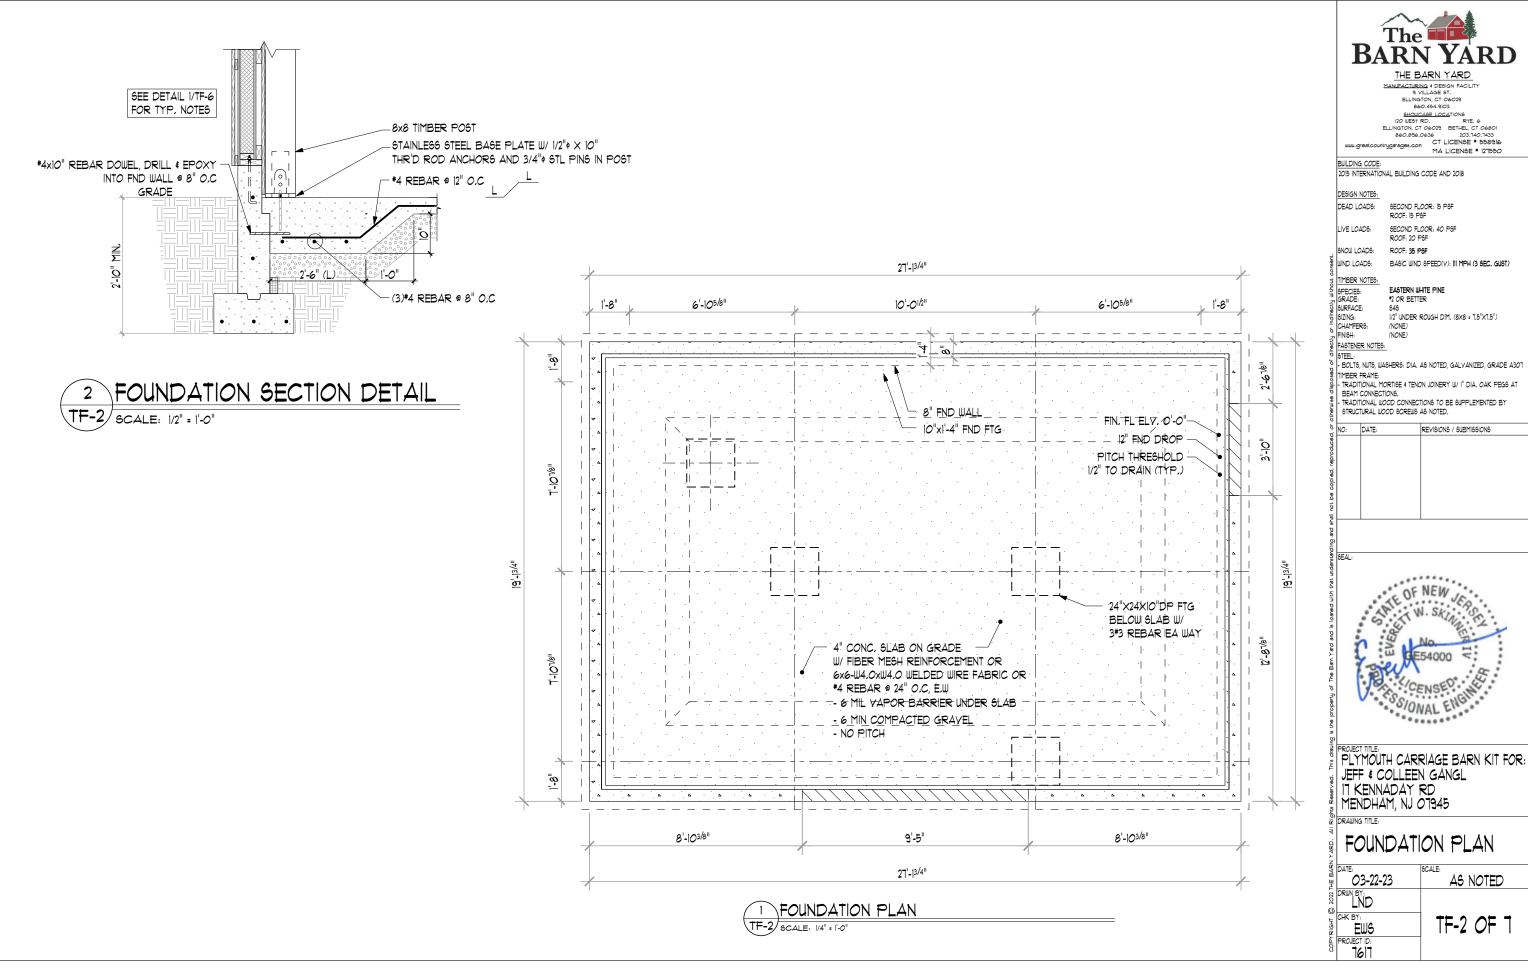






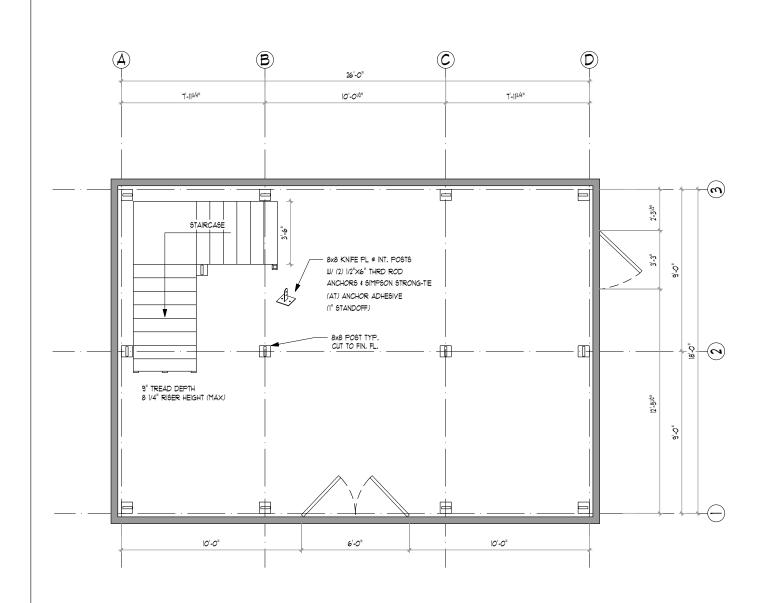



3 REAR 3D RENDERING

TF-3 SCALE: NTS

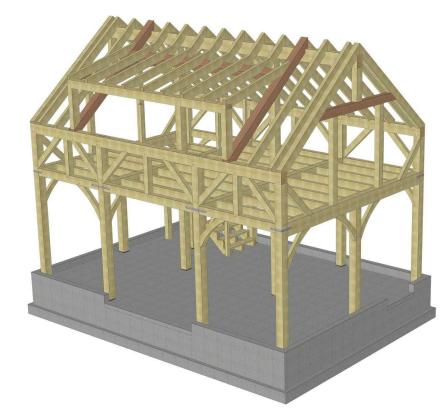

2 FRONT 3D RENDERING TF-3 SCALE: NTS



THE BARN YARD

MANUFACTURING & DESIGN FACILITY
9 VILLAGE ST.
ELLINGTON, CT 06029
860.454.9103

860.494.303

BAGUICABÉ ICCATIONS
12 DUEST RD. RTE. 6

ELINATON, CT 06293 BETHEL, CT 06601
860.986.0536 203.740.7433

CT LICENSE * 558036

MA LICENSE * 121580

BUILDING CODE: 2015 INTERNATIONAL BUILDING CODE AND 2018

DESIGN NOTES: DEAD LOADS:

SECOND FLOOR: 40 PSF LIVE LOADS:

SNOW LOADS: ROOF: 35 PSF

WIND LOADS: BASIC WIND SPEED(Y): III MPH (3 SEC. GUST)

SECOND FLOOR: 15 PSF ROOF: 15 PSF

TIMBER NOTES:

SPECIES:
SPECIE

EASTERN WHITE PINE
12 OR BETTER
949
1/2" UNDER ROUGH DIM. (8X8 = 1,5"X1,5")

(NONE)

៊ី (STEEL: ទី - BOLTS, NUTS, WASHERS: DIA, AS NOTED, GALYANIZED, GRADE A301 BOLIO, NOIS, WARDEROS PIAN, AS NOTED, GALLY ANALES, GRADE AND I IMBER FRAME:

- TRADITIONAL MORTISE 4 TENON JOINERY W/ I* DIA, OAK PEGS AT BEAM CONNECTIONS.

- TRADITIONAL WOOD CONNECTIONS TO BE SUPPLEMENTED BY STRUCTURAL WOOD SCREWS AS NOTED.

REVISIONS / SUBMISSIONS




PROJECT TITLE:
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MENDHAM, NJ 07945


DRAWING TITLE:

POST PLAN

03-22-23 AS NOTED DRWN BY: CHK BY:
EWS
PROJECT ID:
1617 TF-3 OF 7

POST & SILL PLAN TF-3 SCALE: 1/8" = 1'-0"

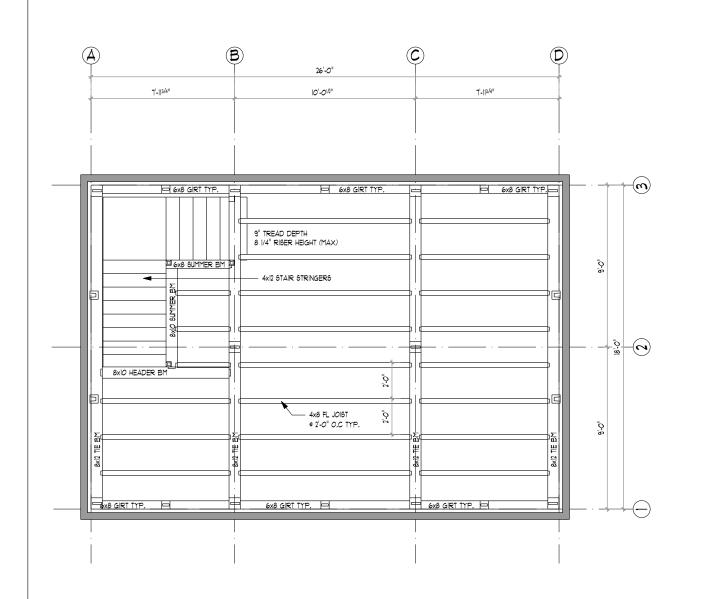

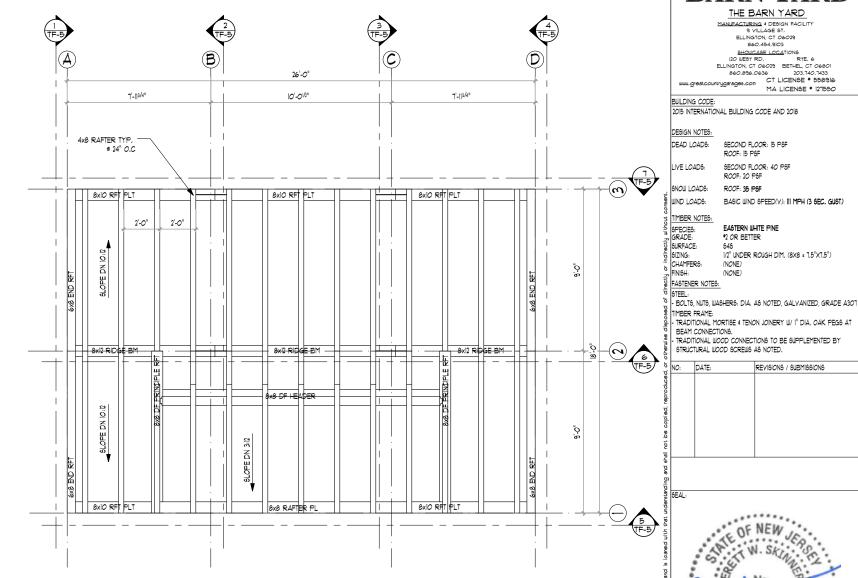

SECOND FLOOR FRAMING PLAN TF-4 SCALE: 1/8" = 1'-0"

ROOF FRAMING PLAN TF-4 SCALE: 1/8" = 1'-0"

- 3"X24" KNIFE PL

FRAMING PLAN

DRAWING TITLE:

JEFF & COLLEEN GANGL 17 KENNADAY RD MENDHAM, NJ 07945

03-22-23 AS NOTED DRWN BY: EWS TF-4 OF 7 PROJECT ID:

ONAL CO

PROJECT TITLE: PLYMOUTH CARRIAGE BARN KIT FOR:

THE BARN YARD MANUFACTURING & DESIGN FACILITY
9 VILLAGE ST.
ELLINGTON, CT 06029
860.454.9103

860.494.303

BAGUICABÉ ICCATIONS
12 DUEST RD. RTE. 6

ELINATON, CT 06293 BETHEL, CT 06601
860.986.0536 203.740.7433

CT LICENSE * 558036

MA LICENSE * 121580

SECOND FLOOR: 15 PSF ROOF: 15 PSF

SECOND FLOOR: 40 PSF

EASTERN WHITE PINE *2 OR BETTER

(NONE)

DATE:


BASIC WIND SPEED(Y): III MPH (3 SEC. GUST)


946 1/2" UNDER ROUGH DIM. (8X8 = 1.5"X1.5")

REVISIONS / SUBMISSIONS

SNOW LOADS: ROOF: 35 PSF

W/ (4) 3/4"×4-1/2" STEEL PINS (1 OF 6)

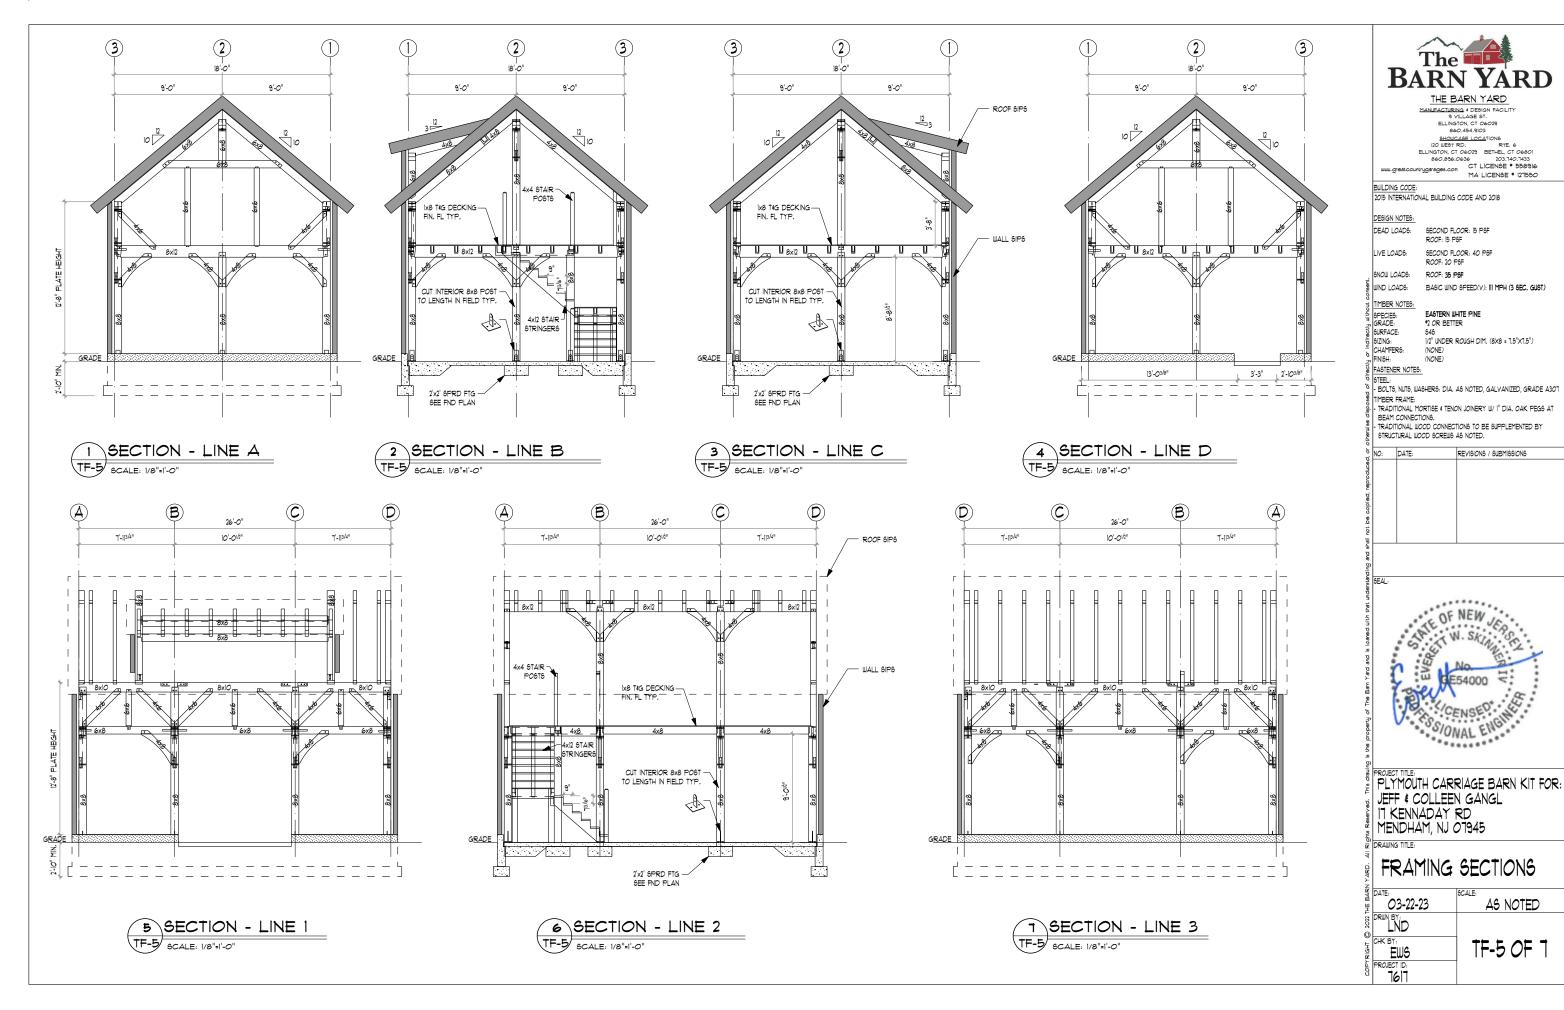


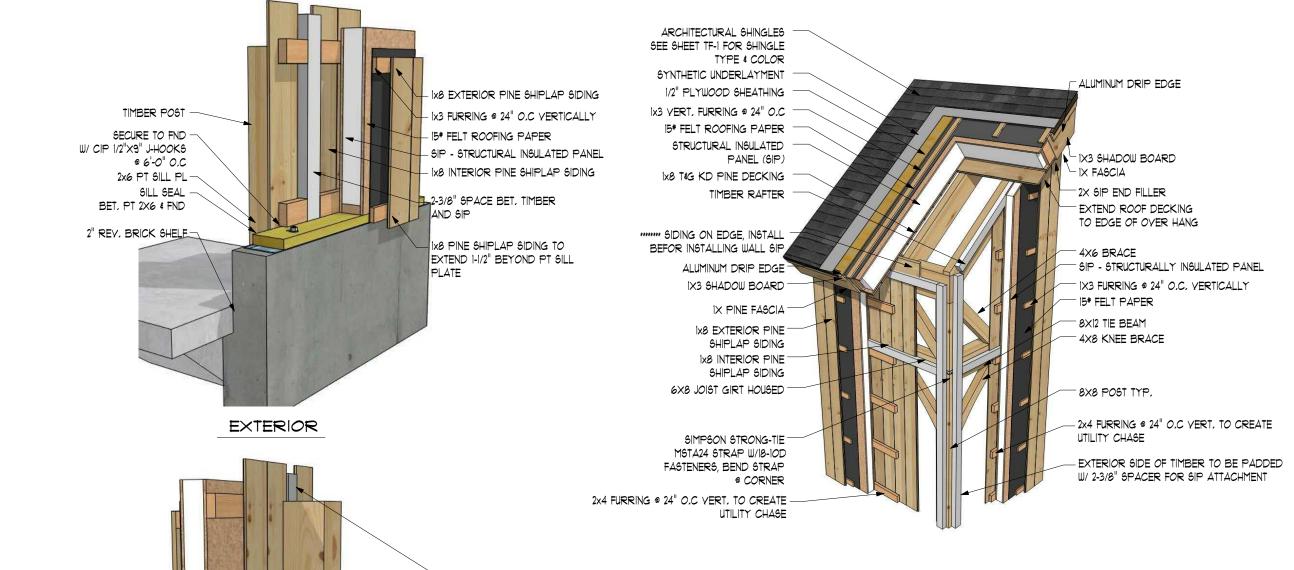

FRAMING DETAIL W/SIP & UTILITY CHASE

SCALE: N.T.S

THESE DETAILS ARE THE BARN YARD'S STANDARD RECOMMENDATION OF BEST PRACTICES FOR SIP PANEL BUILDINGS ONLY AND MAY NOT MATCH THE EXACT CONFIGURATION OF YOUR BUILDING PROJECT, PLEASE CONTACT YOUR PROJECT MANAGER FOR ALL QUESTIONS ABOUT HIGH PERFORMANCE BUILDINGS AND RECOMMENDED FINISHING DETAILS.

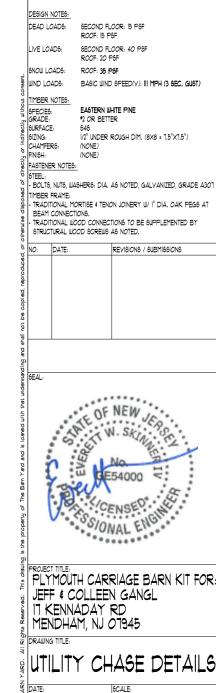

03-22-23

ĽND

EWS

PROJECT ID

AS NOTED

TF-6 OF 1

THE BARN YARD

MANUFACTURING & DESIGN FACILITY
9 VILLAGE ST.

ELLINGTON, CT 06029

860.454.9103

860.494.4103

BHOWCASE ICCA**ION6

IZO WEST RD. RTE, 6

ELLINATION, CT oce 978 BETHE, CT 06801

860.896.0936 203.740.7433

WWW.greatcountryga**ages.com

CT LICENSE * 558046

MA LICENSE * 121550

BUILDING CODE: 2015 INTERNATIONAL BUILDING CODE AND 2018

2" REY, BRICK SHELF-HAUNCHED SLAB PER FND, PLAN 2" R-10 RIGID INSULATION

REBAR DOWEL DRILL & EPOXY INTO FND, WALL PER FND DETAIL

IX8 INTERIOR SHIPLAP PINE SIDING HOLD SIDING 3/4" ABY CONC. FLOOR

INTERIOR FINISHED CONC. SLAB

HAUNCHED REINFORCING PER FND, PLAN

EXTERIOR SIDE OF TIMBER TO BE PADDED

W/ 2-3/8" SPACER FOR SIP ATTACHMENT

- 2x4 FURRING @ 24" O.C YERT, TO CREATE

STAINLESS STEEL BASE PLATE W/ 1/2" ϕ imes 12"

THR'D ROD ANCHORS AND 3/4" & STL PINS IN POST

UTILITY CHASE

INTERIOR

POST HOLD-DOWN W/ SIP & UNILITY CHASE DETAIL

TF-6 SCALE: NTS

STRUCTURAL NOTES:

ALL WORK SHALL CONFORM TO THE CURRENT REQUIREMENTS OF 2015 INTERNATIONAL BUILDING CODE AND RESIDENTIAL BULDING CODE NEW JERSEY EDITION COMBO, DIMENSIONS AND DETAILS SHALL BE CHECKED AGAINST ENGINEERING DRAWINGS.THE CONTRACTORSHALL VERIEY AND COORDINATE THE SIZE AND LOCATION OF ALL OPENINGS, SLEEVES AND ANCHOR BOLTS AS REQUIRED BY ALL TRADES OPENINGS NOT SPECIFICALLY SHOWN SHALL BE APPROVED BY THE ENGINEER, ALL WORK TO CONFORM TO ALL APPLICABLE LOCAL, STATE AND NATIONAL CODES AND REGILIATIONS AND THE OWNERS OR DESIGNATED CONTRACTORS SHALL SECURE APPROPRIATE PERMITS REQUIRED BEFORE COMMENCEMENT OF ACTUAL CONSTRUCTION. ALL CONTRACTORS, SUBCONTRACTORS, SUPPLIERS AND ALL OTHER PERSONS ENGAGED IN ANY CAPACITY ON THIS PROJECT SHALL BE SUBJECT TO PROVISIONS OF THE OSHA (OCCUPATIONAL SAFETY AND HEALTH ADMINISTRATION) WHICH IS ADMINISTERED AND ENFORCED BY U.S. DEPARTMENT OF HEALTH.

FOUNDATIONS:

ALL FOOTINGS SHALL BEAR ON UNDISTURBED NATURAL MATERIAL OR GRANULAR FILL.
ELEVATIONS OF BOTTOM OF FOOTING SHOWN ON PLANS ARE FOR BIDDING PURPOSES AND SHALL BE LOWERED IF NECESSARY TO THE REQUIRED BEARING MATERIAL AS FOUND UPON EXCAVATION. IF THE REQUIRED BEARING MATERIAL IS NOT ENCOUNTERED AT ELEVATIONS SHOWN, NOTIFY ENGINEER IMMEDIATELY, CONTROLLED BACK FILL AND COMPACTION IF REQUIRED.


- A. SCOPE: WHERE UNACCEPTABLE, MATERIAL MUST BE REMOVED AND REPLACED WITH PROPER MATERIAL. A CONTROLLED PROCEDURE MUST BE FOLLOWED TO ENSURE PROPER BEARING FOR THE BUILDING.
- B. FILLING AND GRADING: BEFORE BACK FILLING, REMOVE CONSTRUCTION DEBRIS, STUMPS, TREES, ROOTS, SOD, HEAVY GRASS, DECAYED VEGETABLE MATTER AND OTHER UNSUITABLE MATERIALS, FILL MATERIAL SHALL BE AS APPROVED BY THE ENGINEER.
- **C.** CONSTRUCTION METHODS: AFTER DEPOSITING FILL OR BACK FILL IN 1 FOOT LIFTS, WELL WASHED IN, COMPACT TO THE FOLLOWING PERCENT OPTIMUM DENSITY.

TEST, MATERIALS RETAINED ON THE THREE-QUARTER SIEVE SHALL BE REPLACED WITH MATERIAL RETAINED ON THE NO. 4 SIEVE, AS NOTED AS AN OPTION IN


THE SPECIFICATIONS FOR THIS TEST.

D. FIELD TESTS: PERFORM ONE FIELD DENSITY TEST FOR EACH SOURCE OF FILL MATERIAL PERFORMED IN ACCORDANCE WITH ASTM DISSA, PERFORM STANDARD FIELD DENSITY TESTS EACH OF AN ACCURACY OF PLUS OR MINUS ONE PERCENT, IT SHALL BE THE CONTRACTORS RESPONSIBILITY TO NOTIFY THE ENGINEER AND TESTING LABORATORY WHEN EACH LAYER OF FILL IS TO BE PLACE AND READY FOR TESTING, THE CONTRACTOR SHALL ALLOW AMPLE TIME FOR TESTING, IF ANY FILL IS PLACED IN EXCESS OF SIXTEEN (IS) WITHOUT TESTING, IT SHALL BE SUBJECT TO REMOVAL. SIEVE ANALYSIS SHALL BE AT THE CONTRACTOR'S EXPENSE

E. OBSERVATION: ALL EXCAVATION OF UNACCEPTABLE MATERIAL, INSTALLATION OF CONTROLLED FILL, COMPACTION, FIELD TESTING AND LABORATORY TESTING SHALL BE DONE UNDER THE SUPERVISION OF A TESTING LABORATORY WHO SHALL PROVIDE WRITTEN REPORTS OF ALL PHASES OF THE WORK TO THE FNIGHTER

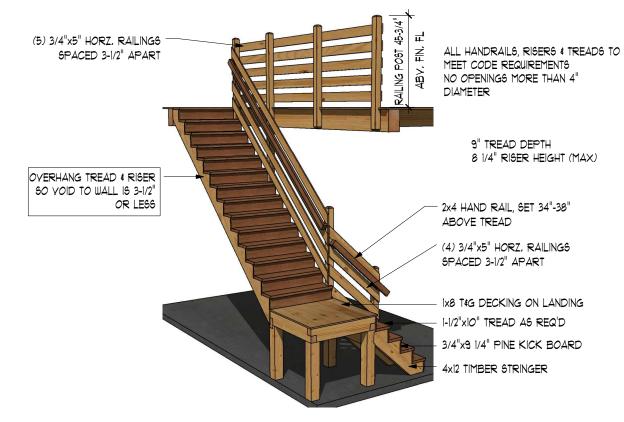

STAIR & HANDRAIL DETAIL

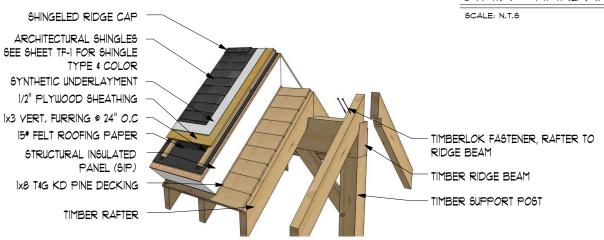


RIDGE BEAM FRAMING DETAIL W/SIP

SCALE: N.T.S

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THE BARN YARD

9 VILLAGE ST.
ELLINGTON, CT 06029
860.454.9103
SHOWCASE LOCATIONS
120 WEST RD. R.

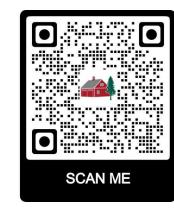BUILDING CODE:

2015 INTERNATIONAL BUILDING CODE AND 2018

DESIGN NOTES

DEAD LOADS: SECOND FLOOR: IS PSF ROOF: IS PSF

LIVE LOADS: SECOND FLOOR: 40 PSF

SNOW LOADS: ROOF: 35 PSF

| WIND LOADS: BASIC WIND SPEED(Y): III MPH (3 SEC. GUST)

TIMBER NOTES:

FINISH:

SPECIES: EASTERN WHITE PINE GRADE: *2 OR BETTER

SURFACE: 546

6|ZING: 1/2" UNDER ROUGH DIM, (8X8 = 1,5"X1,5") CHAMFERS: (NONE)

(NONE)


FASTENER NOTES:

TO BOLTS, NUTS, WASHERS: DIA, AS NOTED, GALYANIZED, GRADE A301

S - TRADITIONAL MORTISE & TENON JOINERY W/ I" DIA, OAK PEGS AT BEAM CONNECTIONS,

TRADITIONAL WOOD CONNECTIONS TO BE SUPPLEMENTED BY STRUCTURAL WOOD SCREWS AS NOTED.

NO: DATE: REVISIONS / SUBMISSIONS

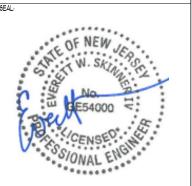

PLYMOUTH CARRIAGE BARN KIT FOR: JEFF & COLLEEN GANGL IT KENNADAY RD MENDHAM, NJ 07945

DRAWING TITLE:

NOTES & DETAILS

DATE: 03-22-23	AS NOTED
DRUN BY: LND	
CHK BY: EWS	TF-7 OF 7
PROJECT ID:	